




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TITLE:	Site, Roof & Sediment Erosion Control Plan	ISSUE	DESCRIPTION	DATE
CLIENT:	Mr. George & Theo Athana	Α	Development Application	13/12/2024
PROJECT:	150 Homer Street, Earlwood	В	Council RFI	19/12/2024
DATE:	19th December 2024	С		
SCALE:	1:200 @ A3	D		





Draft Subdivision Plan

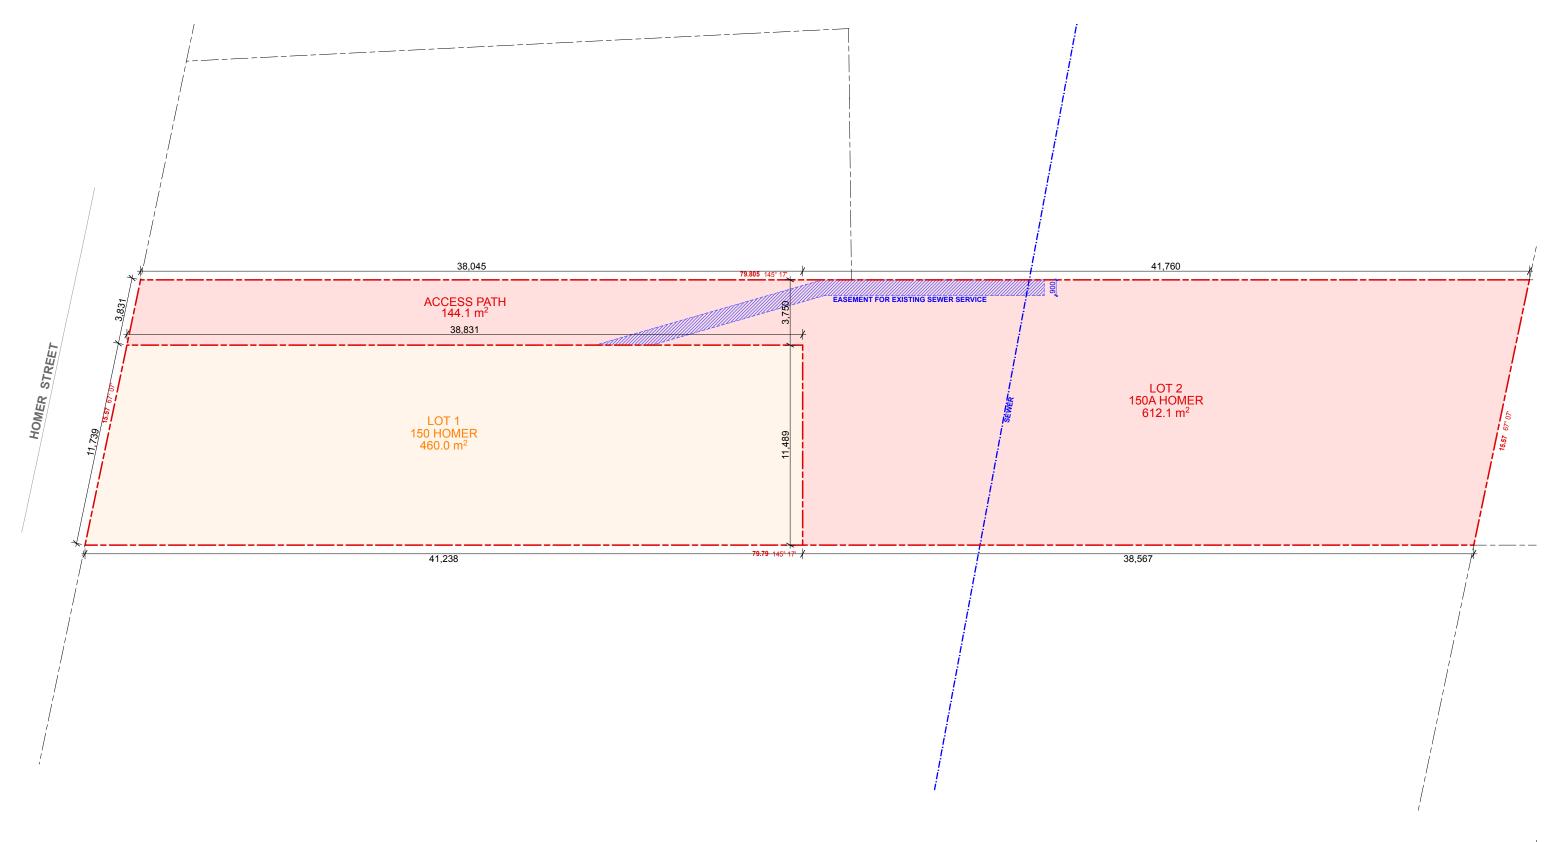

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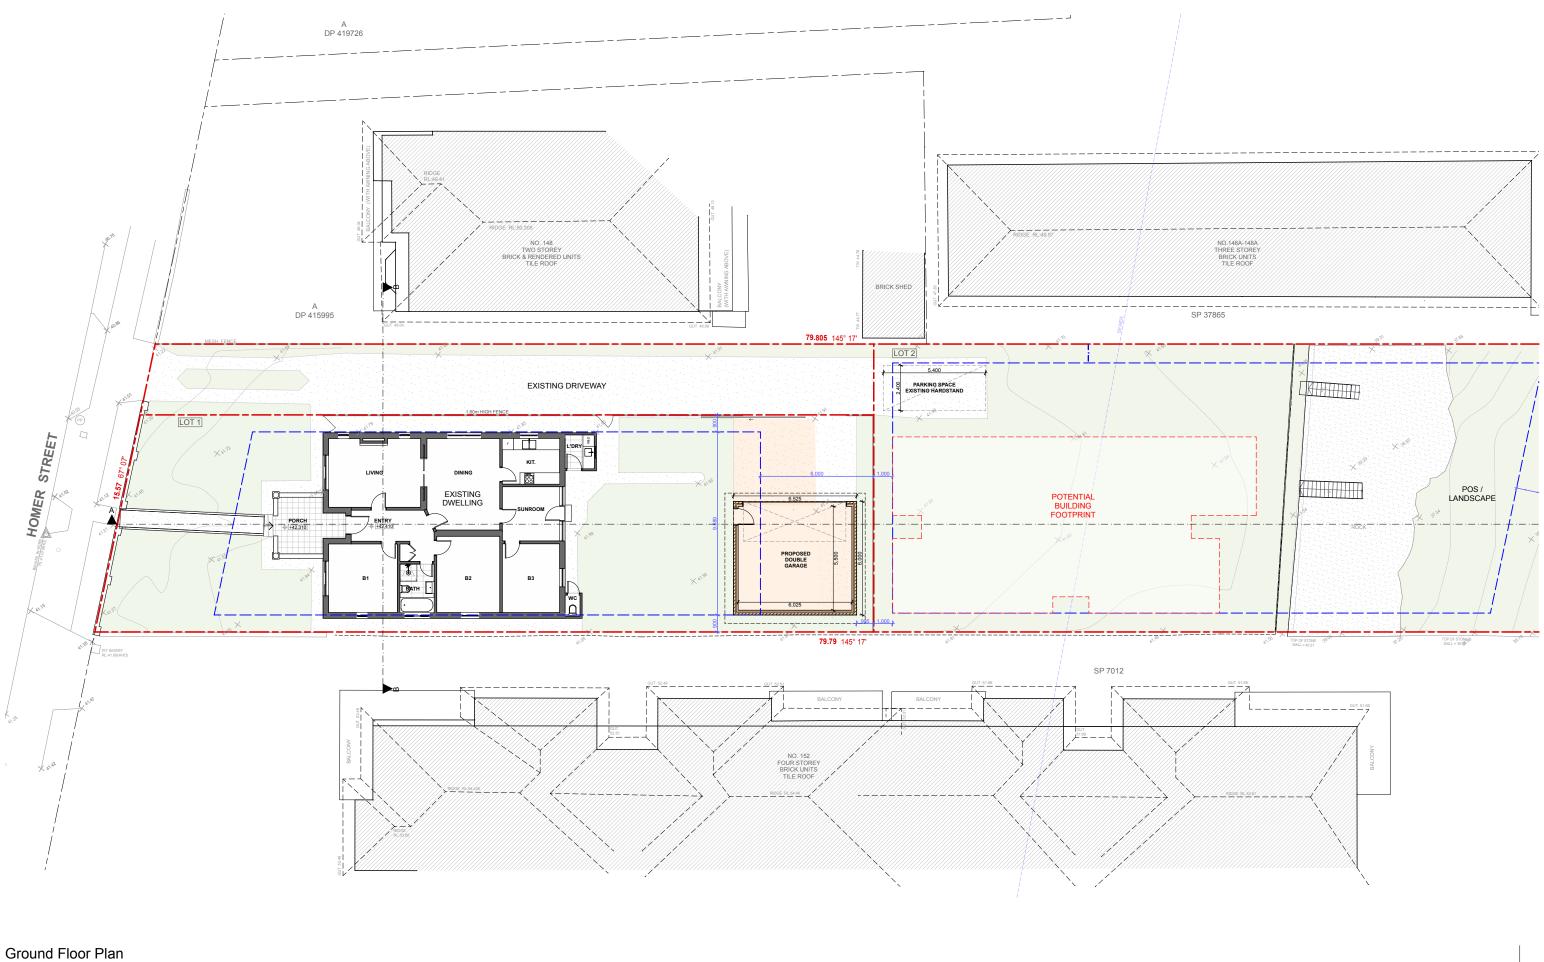
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1:200



CT - CONCRETE ROOF TILE

RT - ROOF TILE BW - FACE BRICK WORK

AR - ACRYLIC RENDER CR - CEMENT RENDER

AS - ALUMINIUM ROOF SHEETING OC - OFF FORM CONCRETE

AL - ALUMINIUM AC - ALUMINIUM CLADDING

FC - FIBRE CEMENT TC - TIMBER CLADDING SC - STONE CLADDING

AD - ALUMINIUM DOOR

AW - ALUMINIUM WINDOW TD - TIMBER DOOR

TW - TIMBER WINDOW FW - FIXED WINDOW GB - GLASS FRAMED BALUSTRADE M - MECHANICAL VENTILATION

© - SMOKE ALARM (ii) - NEW WINDOW

D - NEW DOOR


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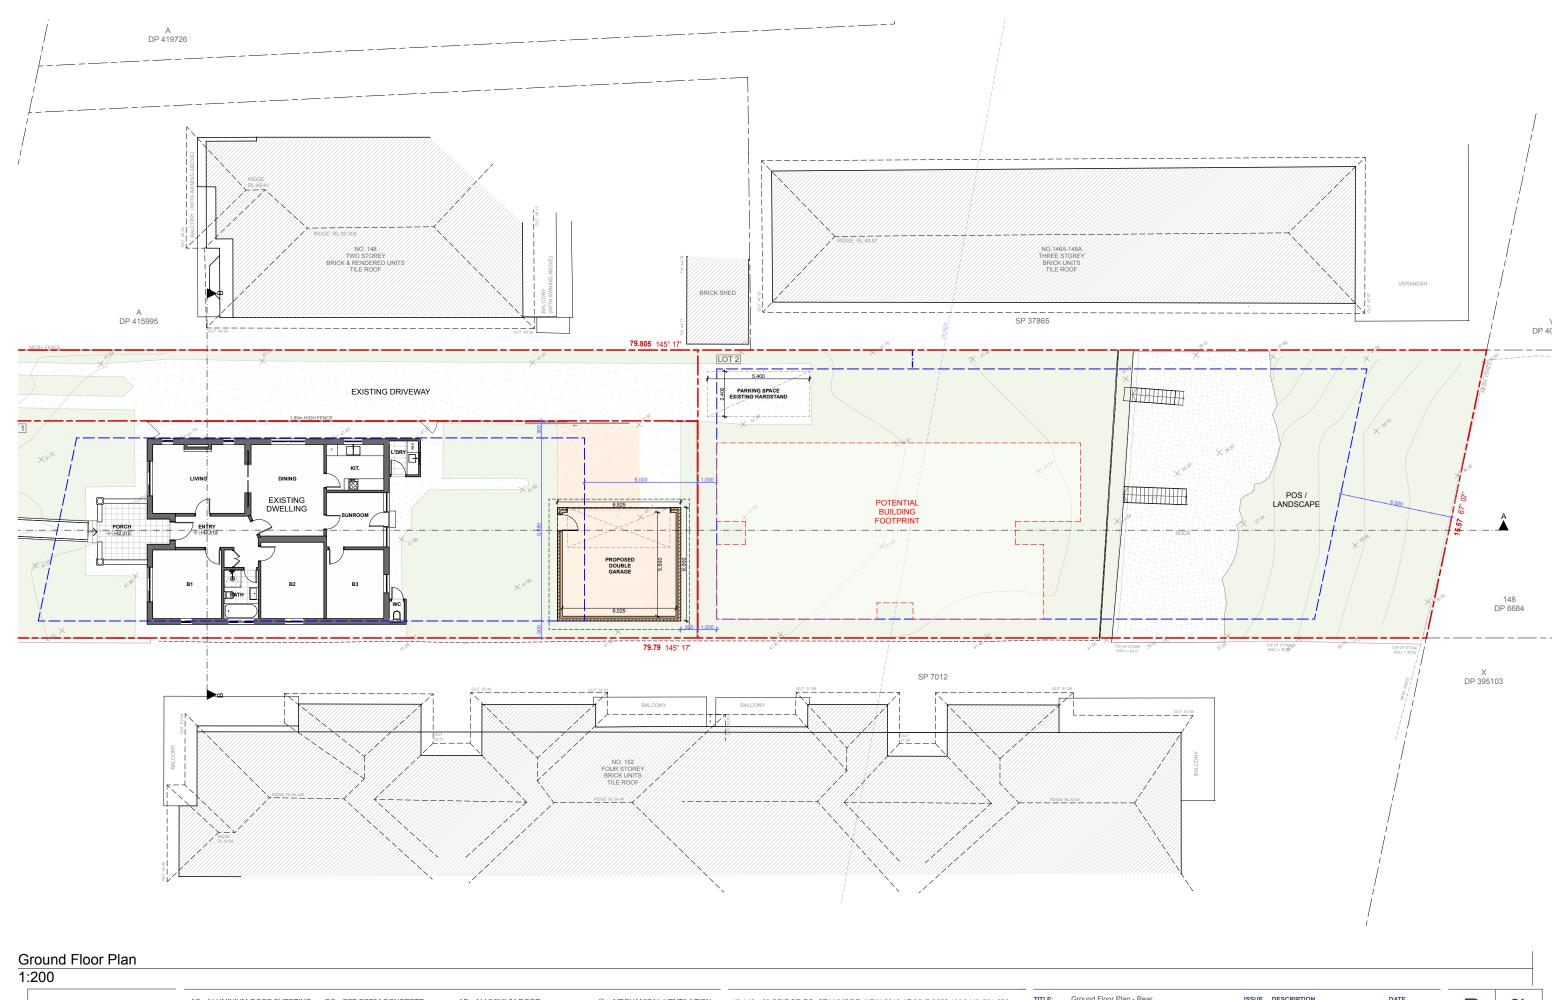
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	CLIENT:	Mr. George & Theo Athana	Α
,	PROJECT:	150 Homer Street, Earlwood	В
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Ground Floor Plan - Front







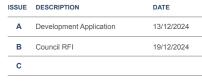

RT - ROOF TILE

BW - FACE BRICK WORK AR - ACRYLIC RENDER CR - CEMENT RENDER

AS - ALUMINIUM ROOF SHEETING OC - OFF FORM CONCRETE

AL - ALUMINIUM

AC - ALUMINIUM CLADDING

FC - FIBRE CEMENT TC - TIMBER CLADDING SC - STONE CLADDING

AD - ALUMINIUM DOOR

AW - ALUMINIUM WINDOW

TD - TIMBER DOOR

GB - GLASS FRAMED BALUSTRADE

TW - TIMBER WINDOW FW - FIXED WINDOW

M - MECHANICAL VENTILATION

© - SMOKE ALARM

(ii) - NEW WINDOW D - NEW DOOR

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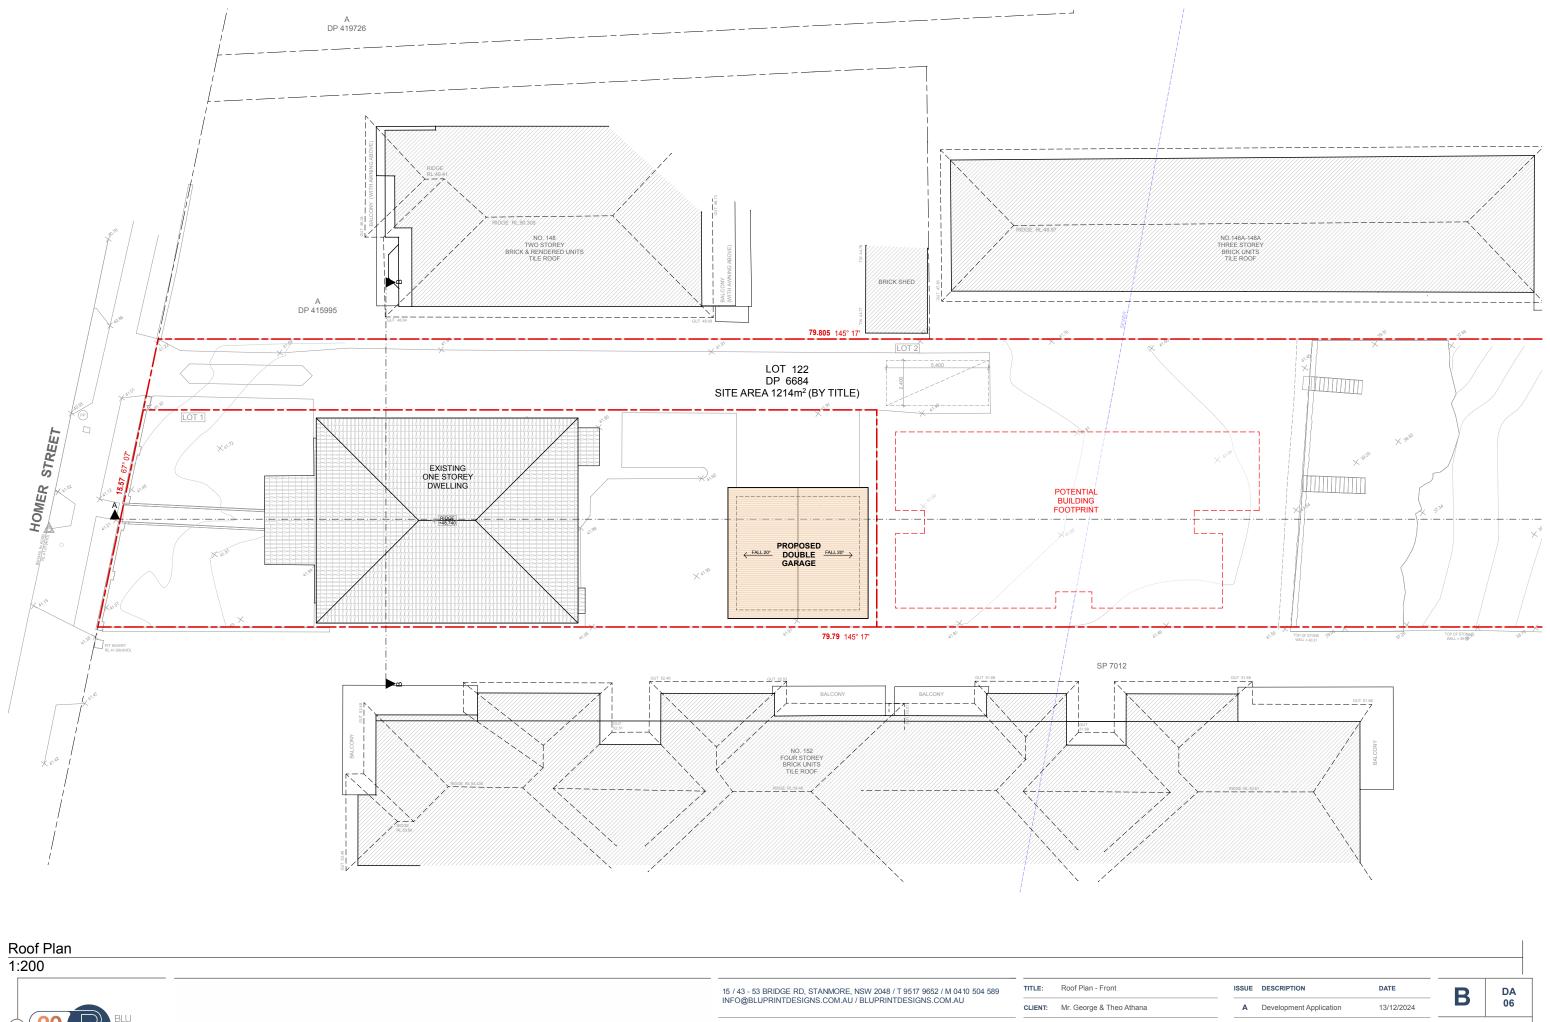
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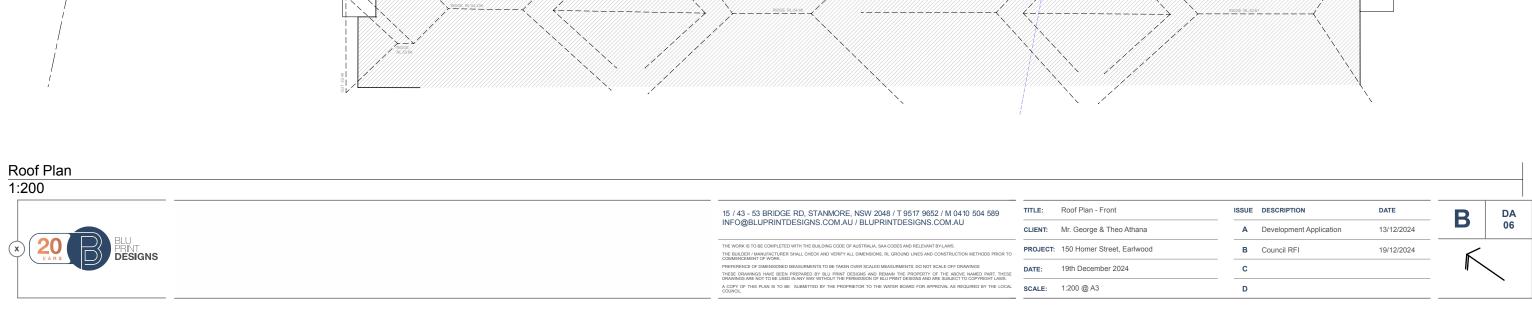
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TITLE:	Ground Floor Plan - Rear	ISSUE	DESCRIPTION
CLIENT:	Mr. George & Theo Athana	Α	Development Application
PROJECT:	150 Homer Street, Earlwood	В	Council RFI
DATE:	19th December 2024	С	
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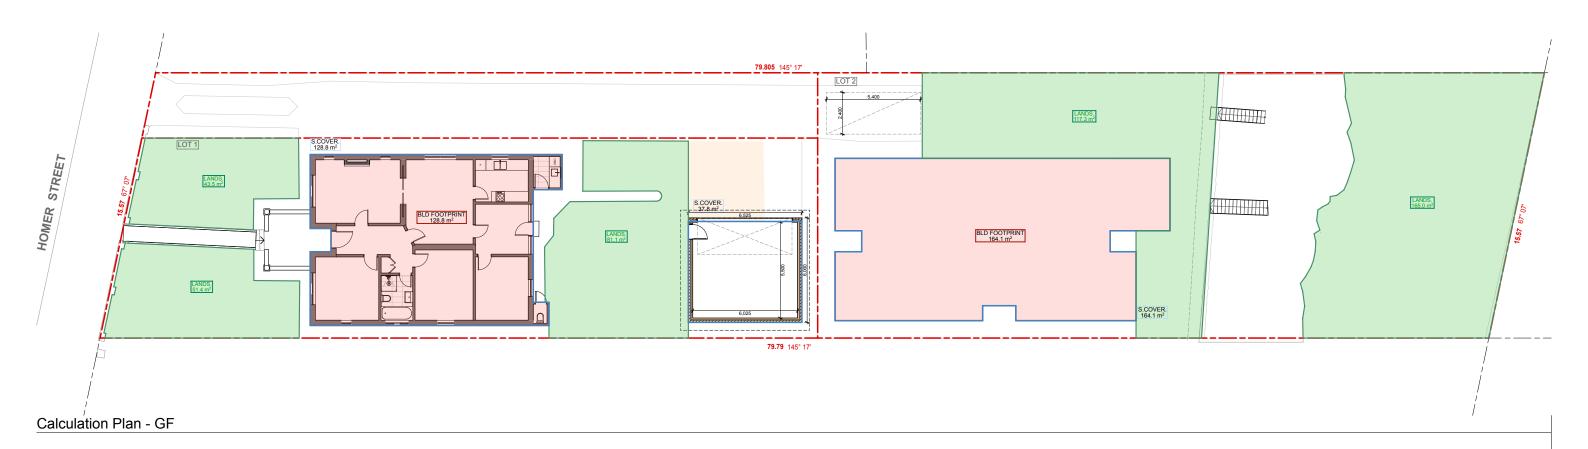




CALCULATIONS

LOT 1					
Site Area		460.0 m	2		
Permited / Required					
1. BUILDING FOOTP	RINT	330.0 m	2		
2. FLOOR AREA OU	TBUILDING	45.0 m	2		
3. SITE COVER		230.0 m	2 =	50%	of Site Area
4. LANDSCAPE	MIN 2.5m	92.0 m	2 =	20%	of Site Area
Proposed					
1. BUILDING FOOTP	RINT	128.8 m	2		
2. FLOOR AREA OUT	BUILDING	0.0 m	2		
3. SITE COVER		166.6 m	2		
4. LANDSCAPE		176.0 m	2		

LOT 2							
Site Area		612.1	m2				
Permited / Required							
1. BUILDING FOOTPRINT		380.0	m2				
2. FLOOR AREA OUTBUILD	ING	60.0	m2				
3. SITE COVER		244.8	m2	=	40%	of Site	Area
4. LANDSCAPE	MIN 2.5m	153.0	m2	=	25%	of Site	Area
Proposed							
1. BUILDING FOOTPRINT		164.1	m2				
2. FLOOR AREA OUTBUILD	ING	0.0	m2				
3. SITE COVER		164.1	m2				
4. LANDSCAPE		282.3	m2				






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TITLE:	Calculation Plans	ISSUE	DESCRIPTION	DATE
CLIENT:	Mr. George & Theo Athana	Α	Development Application	13/12/2024
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BW - FACE BRICK WORK AR - ACRYLIC RENDER CR - CEMENT RENDER

AS - ALUMINIUM ROOF SHEETING OC - OFF FORM CONCRETE

FC - FIBRE CEMENT

TC - TIMBER CLADDING

SC - STONE CLADDING

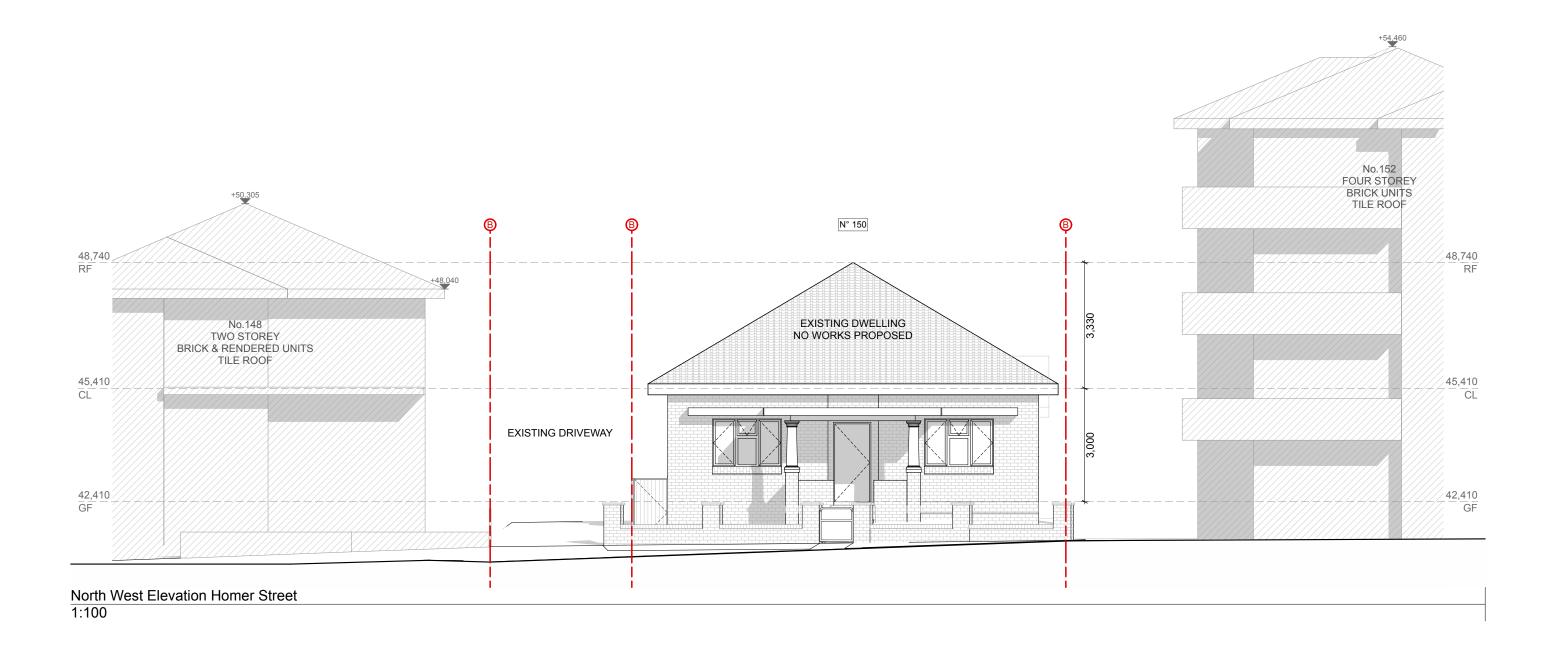AL - ALUMINIUM AC - ALUMINIUM CLADDING

AW - ALUMINIUM WINDOW TD - TIMBER DOOR TW - TIMBER WINDOW FW - FIXED WINDOW

GB - GLASS FRAMED BALUSTRADE

AD - ALUMINIUM DOOR

M - MECHANICAL VENTILATION

© - SMOKE ALARM W - NEW WINDOW

① - NEW DOOR

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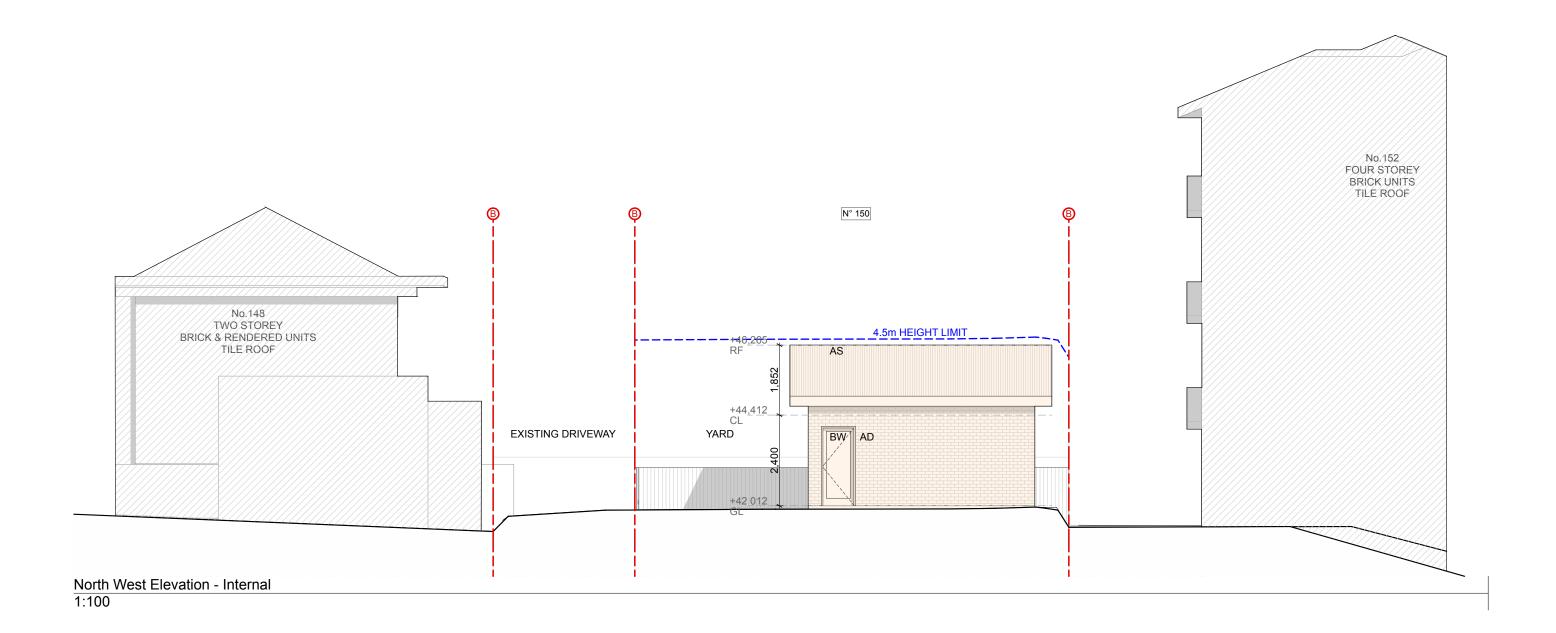
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TITLE:	North West Elevations	ISSUE	DESCRIPTION	DATE
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PROJECT:	150 Homer Street, Earlwood	В	Council RFI	19/12/2024
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B

DA 08





RT - ROOF TILE

CR - CEMENT RENDER

BW - FACE BRICK WORK AR - ACRYLIC RENDER

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TD - TIMBER DOOR TW - TIMBER WINDOW

GB - GLASS FRAMED BALUSTRADE

© - SMOKE ALARM W - NEW WINDOW

M - MECHANICAL VENTILATION

D - NEW DOOR

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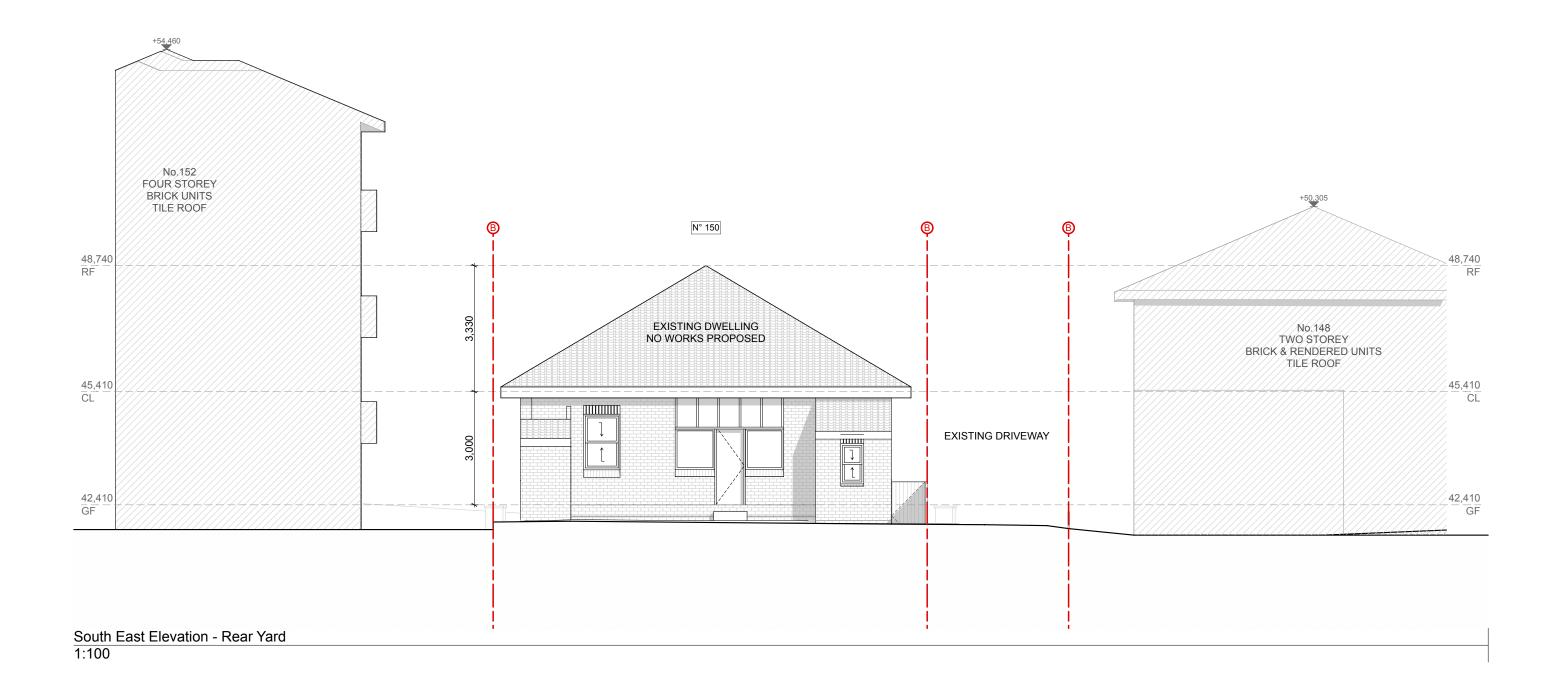
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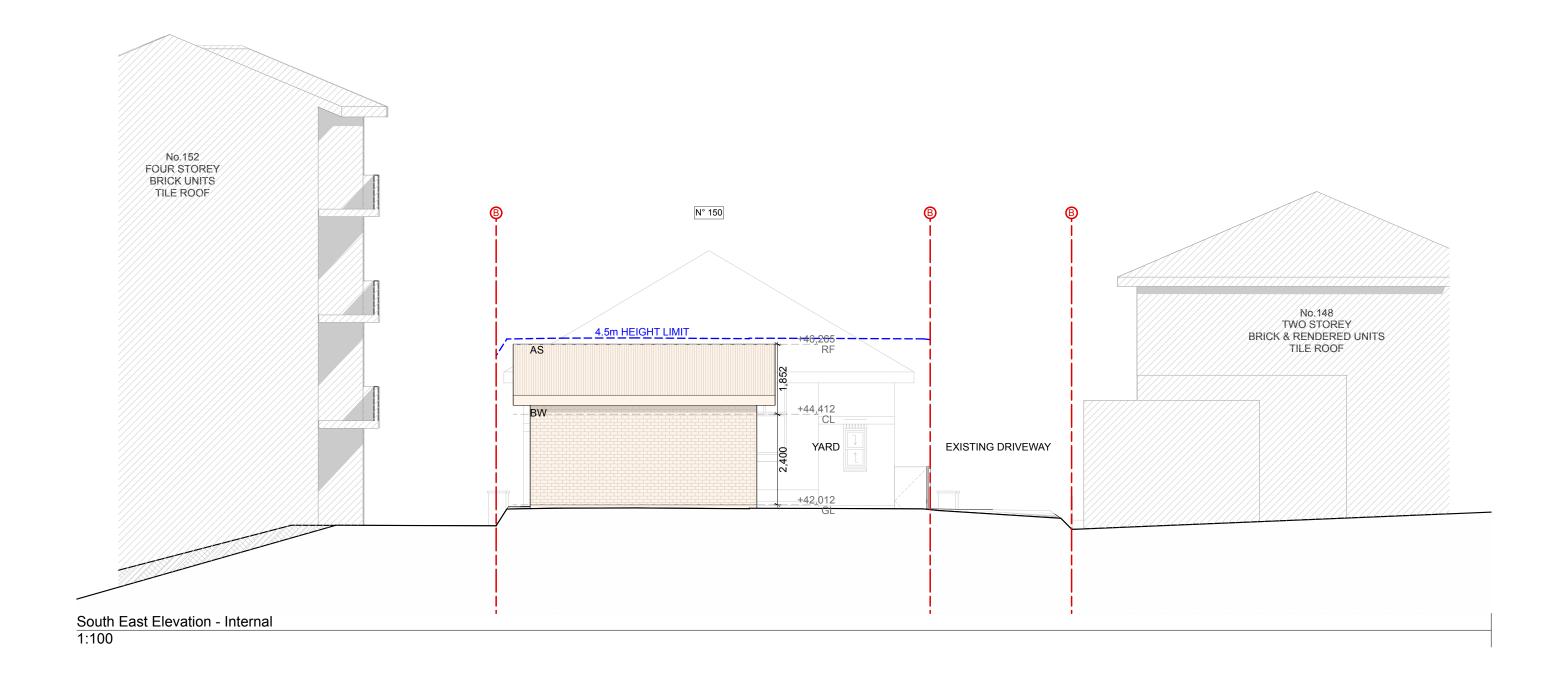
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TITLE:	South East Elevations	ISSUE	DESCRIPTION	DATE
CLIENT:	Mr. George & Theo Athana	Α	Development Application	13/12/2024
PROJECT:	150 Homer Street, Earlwood	В	Council RFI	19/12/2024
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B DA 10





RT - ROOF TILE

BW - FACE BRICK WORK

FC - FIBRE CEMENT AR - ACRYLIC RENDER TC - TIMBER CLADDING CR - CEMENT RENDER SC - STONE CLADDING

AS - ALUMINIUM ROOF SHEETING OC - OFF FORM CONCRETE

AL - ALUMINIUM AC - ALUMINIUM CLADDING

TD - TIMBER DOOR TW - TIMBER WINDOW FW - FIXED WINDOW

AD - ALUMINIUM DOOR AW - ALUMINIUM WINDOW

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© - SMOKE ALARM

M - MECHANICAL VENTILATION

W - NEW WINDOW D - NEW DOOR

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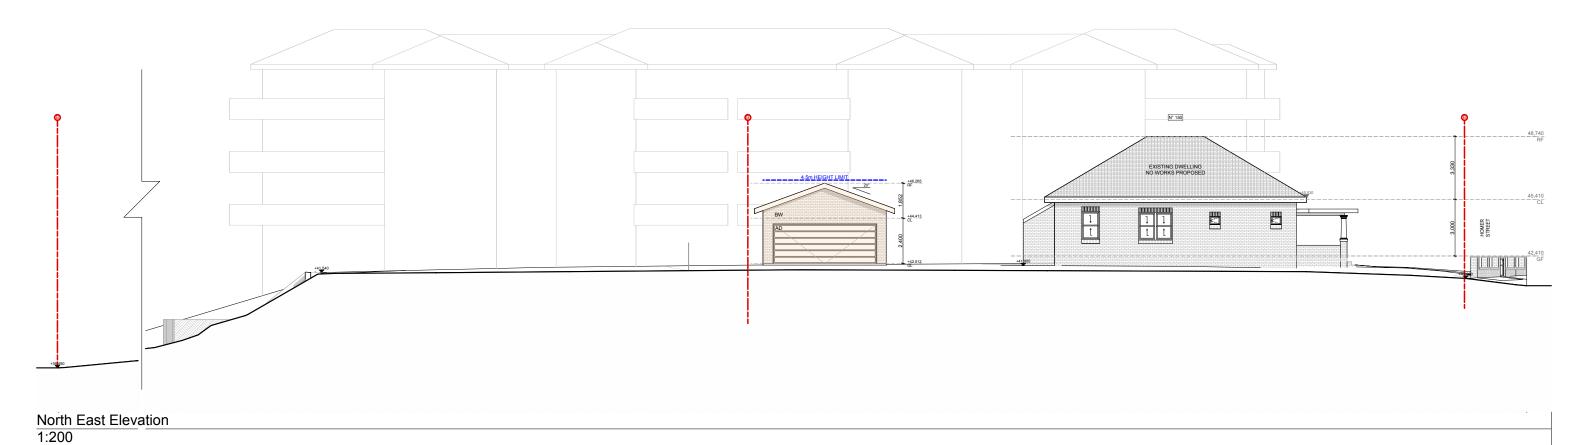
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N° 150 48,740 RF 45,410 CL HOMER

South West Elevation

1:200



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RT - ROOF TILE

BW - FACE BRICK WORK AR - ACRYLIC RENDER

AS - ALUMINIUM ROOF SHEETING OC - OFF FORM CONCRETE

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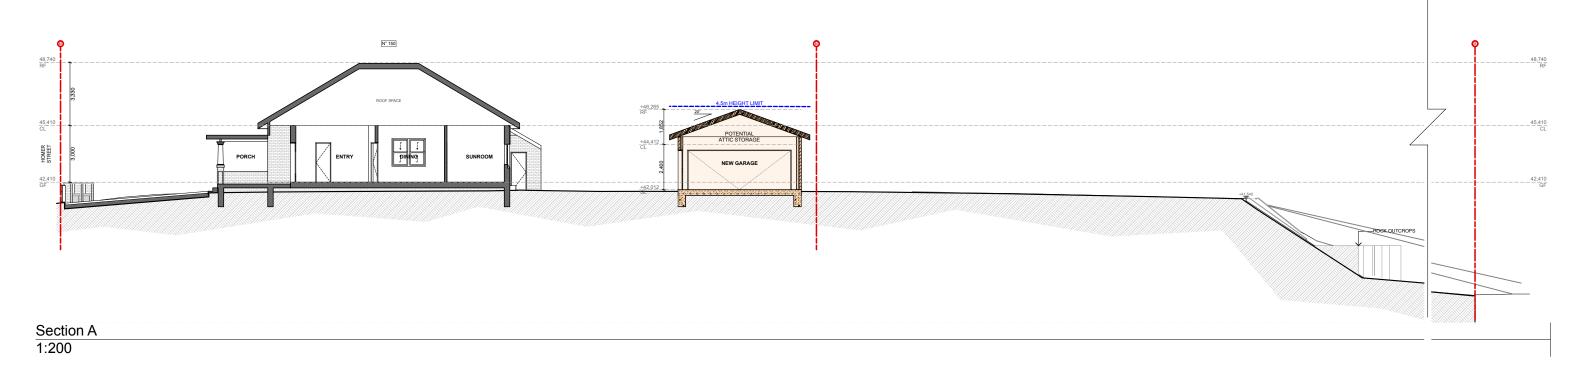
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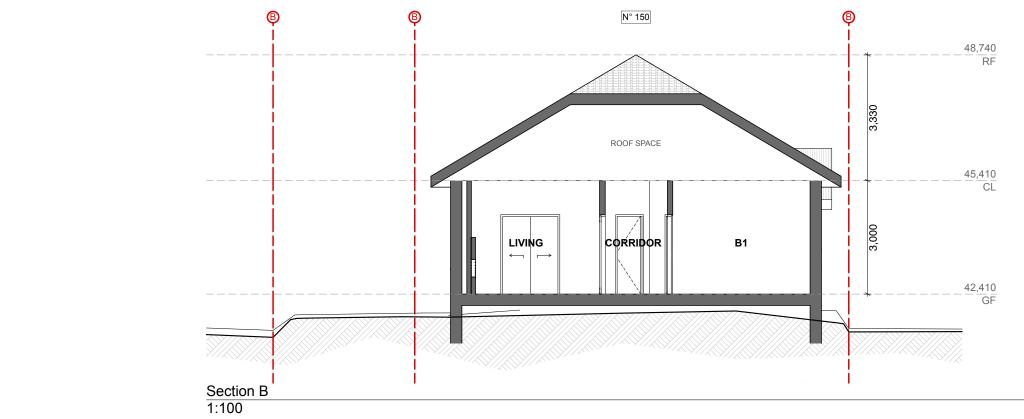
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TITLE:	North East & South West Elevations	ISSUE	DESCRIPTION	DATE
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DA 12

В







AS - ALUMINIUM ROOF SHEETING OC - OFF FORM CONCRETE CT - CONCRETE ROOF TILE

RT - ROOF TILE BW - FACE BRICK WORK

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(ii) - NEW WINDOW D - NEW DOOR TW - TIMBER WINDOW FW - FIXED WINDOW

© - SMOKE ALARM


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1	TITLE:	Sections A & B	ISSUE	DESCRIPTION	DATE	
(CLIENT:	Mr. George & Theo Athana r: 150 Homer Street, Earlwood		Development Application	13/12/2024	
F	PROJECT:			Council RFI	19/12/2024	
	DATE:	19th December 2024	С			
5	SCALE:	1:100, 1:200 @ A3	D			

В

DA 13



KEY

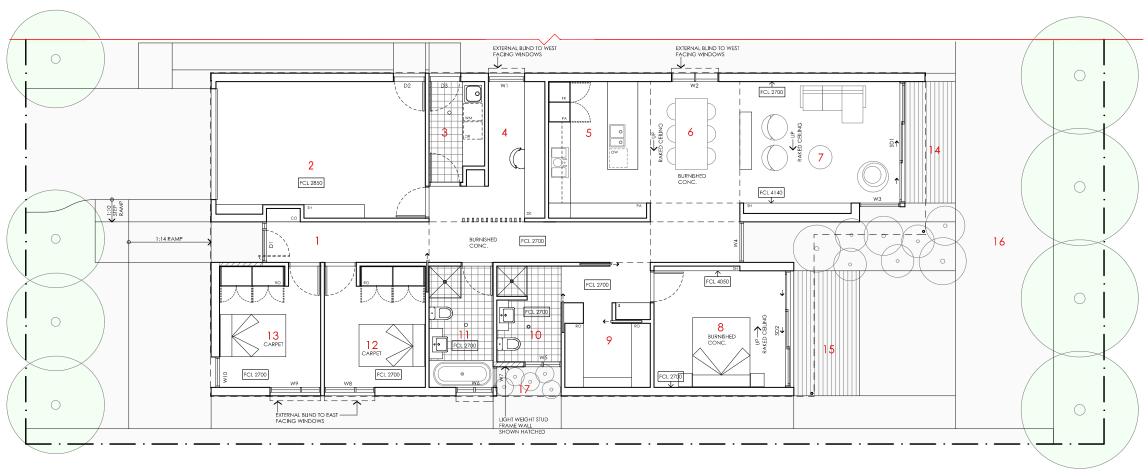- ENTRY
- FAMILY
- LAUNDRY STUDY
- KITCHEN DINING
- LIVING
- BEDROOM 1 WALK IN ROBE
- ENSUITE BATHROOM
- BEDROOM 2
- BEDROOM 3 LIVING ROOM DECK
- BEDROOM 1 DECK NORTHERN YARD

LEGEND fr fridge pa pantry

- PA PANTRY
 DW DISH WASHER
 RO ROBE
 DE DESK
 ST STORAGE CUPBOARD
 SHE LYING
 WM WASHING MACHINE
 DR CLOTHES DRYER
 CO COAT CUPBOARD
 IL LINEN CUPBOARD
 FGL FINISHED CELLING LEVEL



MALLEE HOUSE

NOTES

AREA

GROUND FLOOR LIVING 148 m2 GARAGE 26 m2 TOTAL GFA 174 m2

GROUND FLOOR DECKS 30 m2
INDICATIVE BLOCK SIZE 384 m2
REFER TO NOC FOR SANIARY COMPARIMENT CIRCULATION, WALL
RENFORCEMENT AND THRESHOLD/HOS REQUIREMENTS DOOR OPENINGS, CORRIDOR WIDTHS AND THRESHOLDS, ENTRY RAMI GRADES AND COVER ETC TO NCC REQUIREMENTS

SETBACK FROM BOUNDARIES SHOWN INDICATIVELY ONLY - REVISE TO SUIT LOCAL REGULATIONS AND BUILDING ENVELOPES ETC

NOTE: GFA CALCULATIONS DO NOT INCLUDE DECKS, TERRACES, COURTYARDS, VERANDAHS, VOIDS, STAIRS & BALCONIES ® LIFL, NOTE THAT INTERNAL ROOM DIMENSIONS ARE NOMINAL ONLY. CEILING INSULATION VALUES SPECIFIED EXTEND TO EAVES

PROJECT

DISCLAIMER







DESIGNED FOR

Mallee House

Sydney

DESIGN

Technical drawings should be read with the Mallee House Sydney 'Design Options' document which includes building specifications and rating information.

DETAILS

Drawing title: Floor Plan

Scale: 1:100 Paper size: A3

Drawing number: 2/11 Date issued: June 2023

Project stage: Preliminary



AS - ALUMINIUM ROOF SHEETING OC - OFF FORM CONCRETE CT - CONCRETE ROOF TILE

RT - ROOF TILE BW - FACE BRICK WORK AR - ACRYLIC RENDER

CR - CEMENT RENDER

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SC - STONE CLADDING

AD - ALUMINIUM DOOR

AW - ALUMINIUM WINDOW

TD - TIMBER DOOR

GB - GLASS FRAMED BALUSTRADE

liabilities, losses, damages and costs arising from any reliance on the contents of this plan.

D - NEW DOOR TW - TIMBER WINDOW FW - FIXED WINDOW

(M) - MECHANICAL VENTILATION

This house plan is a guide only. It does not constitute legal or other professional advice. You should seek legal or other professional advice in relation

requirements. The Commonwealth does not accept responsibility for the accuracy or completeness of this plan, its fitness for a particular purpose, or

compliance with any regulatory requirements and standards. Further, the Commonwealth also disclaims liability, to the extent permitted by law, for any

to your specific circumstances before adopting any recommendation made within it e.g. advice on structural engineering or building certification

S - SMOKE ALARM W - NEW WINDOW

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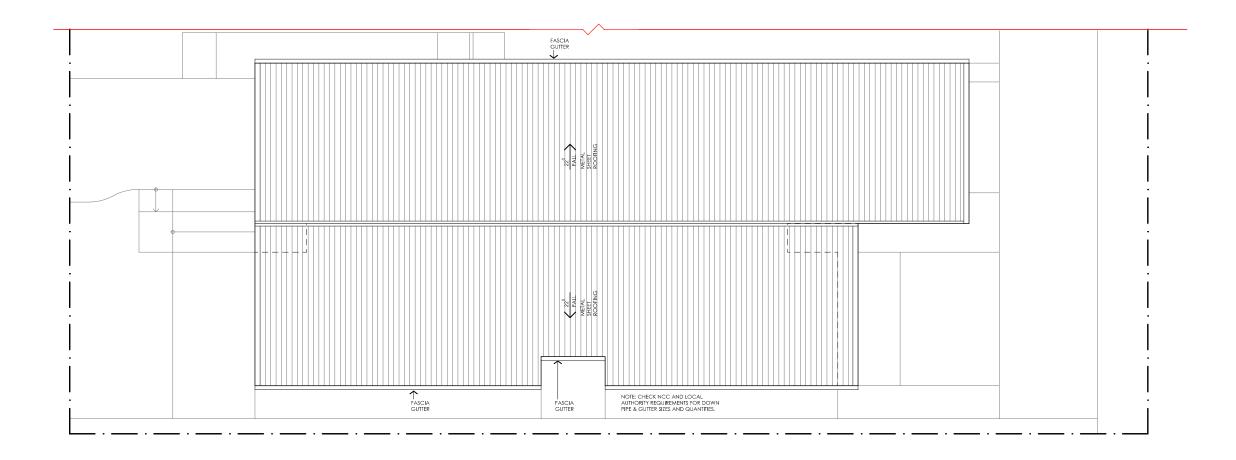
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TITLE:	Potential Building Floor Plan
CLIENT:	Mr. George & Theo Athana
PROJECT:	150 Homer Street, Earlwood
DATE:	19th December 2024
SCALE:	NTS

ISSUE	DESCRIPTION	DATE
Α	Development Application	13/12/2024
В	Council RFI	19/12/2024
С		
D		









MALLEE HOUSE

LEGEND

N/A

PROJECT

DISCLAIMER







DESIGN Mallee House

DESIGNED FOR

Sydney

Technical drawings should be read with the Mallee House Sydney 'Design Options' document which includes building specifications and rating information.

DETAILS

Drawing title: Roof Plan

Scale: 1:100 Paper size: A3

Drawing number: 3/11 Date issued: June 2023

Project stage: Preliminary



B



AS - ALUMINIUM ROOF SHEETING OC - OFF FORM CONCRETE CT - CONCRETE ROOF TILE

RT - ROOF TILE BW - FACE BRICK WORK AR - ACRYLIC RENDER

CR - CEMENT RENDER

AC - ALUMINIUM CLADDING

FC - FIBRE CEMENT TC - TIMBER CLADDING SC - STONE CLADDING

AD - ALUMINIUM DOOR AW - ALUMINIUM WINDOW

TD - TIMBER DOOR

GB - GLASS FRAMED BALUSTRADE

liabilities, losses, damages and costs arising from any reliance on the contents of this plan.

TW - TIMBER WINDOW FW - FIXED WINDOW

M - MECHANICAL VENTILATION S - SMOKE ALARM

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compliance with any regulatory requirements and standards. Further, the Commonwealth also disclaims liability, to the extent permitted by law, for any

to your specific circumstances before adopting any recommendation made within it e.g. advice on structural engineering or building certification

W - NEW WINDOW D - NEW DOOR


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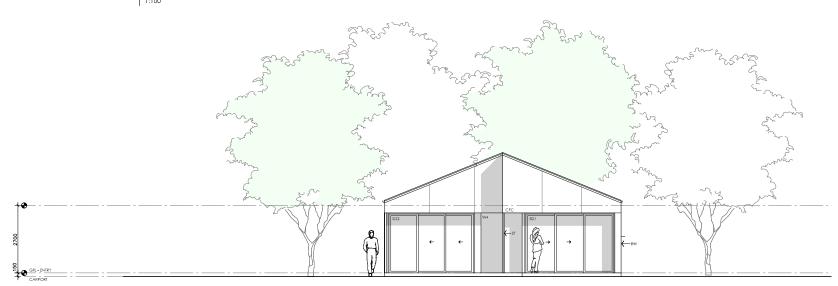
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TITLE:	Potential Building Roof Plan	ISSUE	DESCRIPTION	DATE
CLIENT:	Mr. George & Theo Athana	Α	Development Application	13/12/2024
PROJECT:	150 Homer Street, Earlwood	В	Council RFI	19/12/2024
DATE:	19th December 2024	С		
SCALE:	NTS	D		







01 NORTH ELEVATION

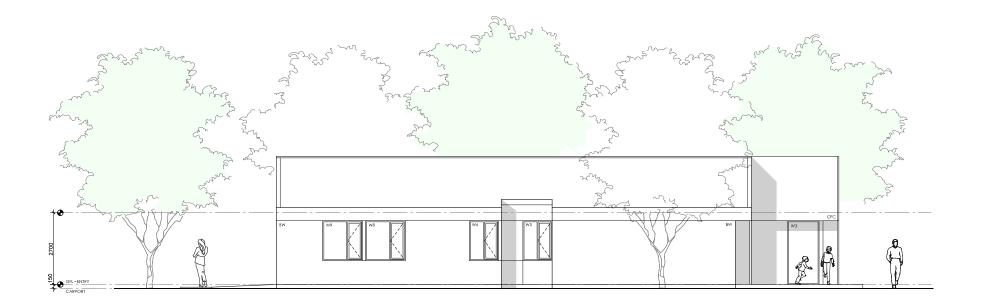MALLEE HOUSE

LEGEND

- BW FACE BRICK WALL TYPE & COLOUR TBC WB WEATHERBOARD CLADDING TYPE & COLOUR TBC
- CFC COMPRESSED FC SHEET ON TIMBER FRAME EXPRESSED JOINT AT EDGES INDICATED
- MF FOLDED METAL FASCIA COLOUR TBC
- ST STEEL WORK COLOUR TBC
- GD GARAGE DOOR COLOUR TBC
- ALUMINIUM COVER PLATE COLOUR TO MATCH WINDOW FRAMES

PROJECT







DESIGNED FOR Sydney

Mallee House

DESIGN

Technical drawings should be read with the Mallee House Sydney 'Design Options' document which includes building specifications and rating information.

DETAILS

Drawing title: Elevation-East

Scale: 1:100 Paper size: A3

Drawing number: 4/11 Date issued: June 2023 Project stage: Preliminary

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AS - ALUMINIUM ROOF SHEETING OC - OFF FORM CONCRETE CT - CONCRETE ROOF TILE

RT - ROOF TILE

BW - FACE BRICK WORK AR - ACRYLIC RENDER

CR - CEMENT RENDER

AC - ALUMINIUM CLADDING

FC - FIBRE CEMENT

TC - TIMBER CLADDING

SC - STONE CLADDING

AD - ALUMINIUM DOOR AL - ALUMINIUM

AW - ALUMINIUM WINDOW TD - TIMBER DOOR

TW - TIMBER WINDOW FW - FIXED WINDOW

GB - GLASS FRAMED BALUSTRADE

W - NEW WINDOW D - NEW DOOR


(M) - MECHANICAL VENTILATION 15 / 43 - 53 BRIDGE RD, STANMORE, NSW 2048 / T 9517 9652 / M 0410 504 589 INFO@BLUPRINTDESIGNS.COM.AU / BLUPRINTDESIGNS.COM.AU S - SMOKE ALARM


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	TITLE:	Potential Building Elevations
	CLIENT:	Mr. George & Theo Athana
	PROJECT:	150 Homer Street, Earlwood
E	DATE:	19th December 2024
L	SCALE:	NTS

	ISSUE	DESCRIPTION	DATE
	Α	Development Application	13/12/2024
	В	Council RFI	19/12/2024
	С		
-	D		





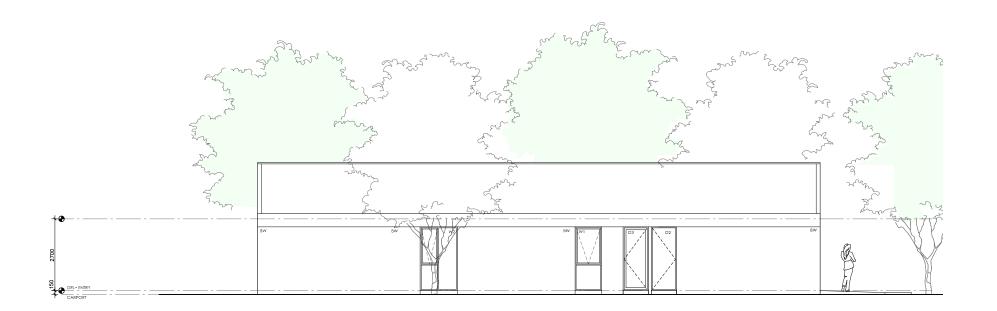

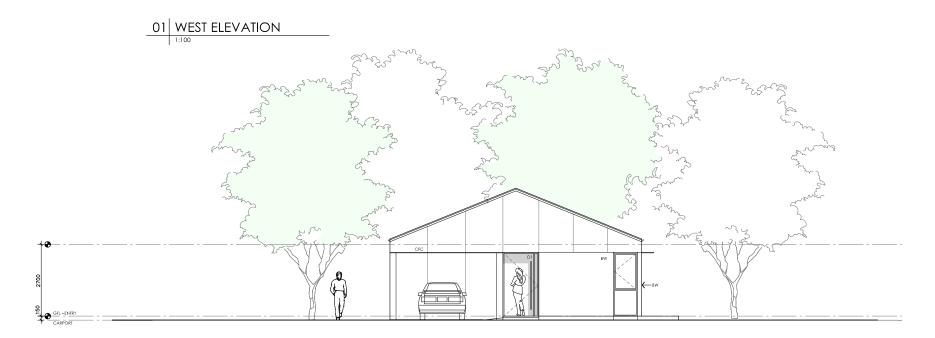01 SOUTH ELEVATION

MALLEE HOUSE

LEGEND

- BW FACE BRICK WALL TYPE & COLOUR TBC WB WEATHERBOARD CLADDING TYPE & COLOUR TBC
- CFC COMPRESSED FC SHEET ON TIMBER FRAME EXPRESSED JOINT AT EDGES INDICATED
- MF FOLDED METAL FASCIA COLOUR TBC
- ST STEEL WORK COLOUR TBC
- GD GARAGE DOOR COLOUR TBC
- ALUMINIUM COVER PLATE COLOUR TO MATCH WINDOW FRAMES

PROJECT







DESIGNED FOR Sydney

DESIGN

Mallee House

Technical drawings should be read with the Mallee House Sydney 'Design Options' document which includes building specifications and rating information.

DETAILS

Drawing title: Elevation-West

Scale: 1:100 Paper size: A3

Drawing number: 7/11 Date issued: June 2023 Project stage: Preliminary

B

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RT - ROOF TILE

BW - FACE BRICK WORK AR - ACRYLIC RENDER CR - CEMENT RENDER

AL - ALUMINIUM AC - ALUMINIUM CLADDING

FC - FIBRE CEMENT TC - TIMBER CLADDING

SC - STONE CLADDING

AD - ALUMINIUM DOOR

AW - ALUMINIUM WINDOW

TD - TIMBER DOOR TW - TIMBER WINDOW

GB - GLASS FRAMED BALUSTRADE

D - NEW DOOR FW - FIXED WINDOW


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S - SMOKE ALARM W - NEW WINDOW

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TITLE:	Potential Building Elevations	ISSUE	DESCRIPTION	DATE
CLIENT:	Mr. George & Theo Athana	Α	Development Application	13/12/202
PROJECT:	150 Homer Street, Earlwood	В	Council RFI	19/12/202
DATE:	19th December 2024	С		
SCALE:	NTS	D		



SHADOW DIAGRAM LEGEND



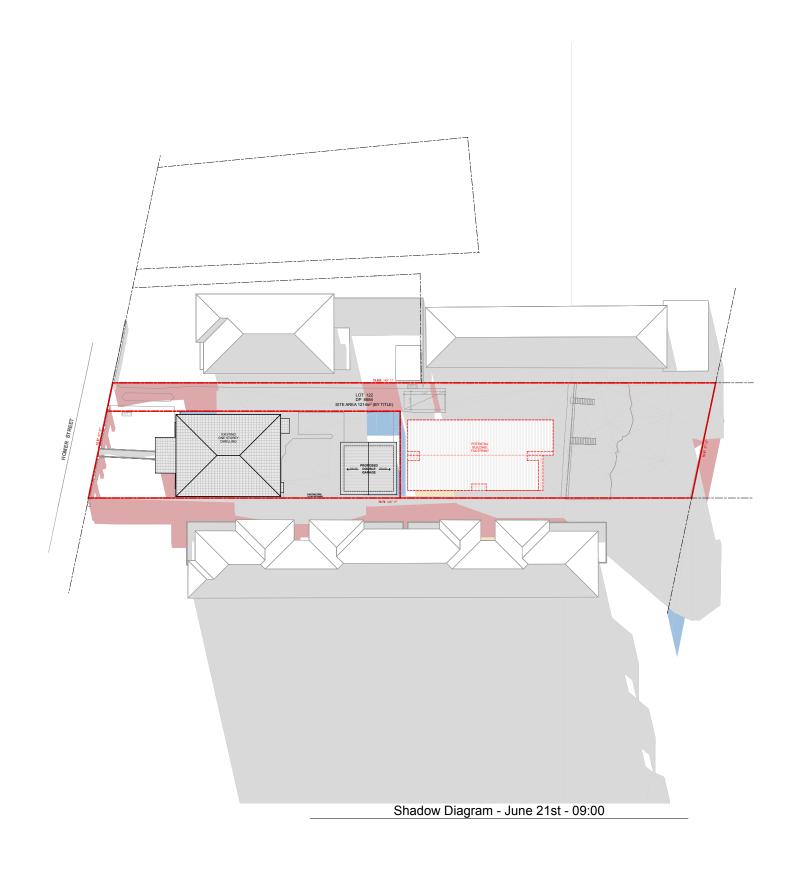

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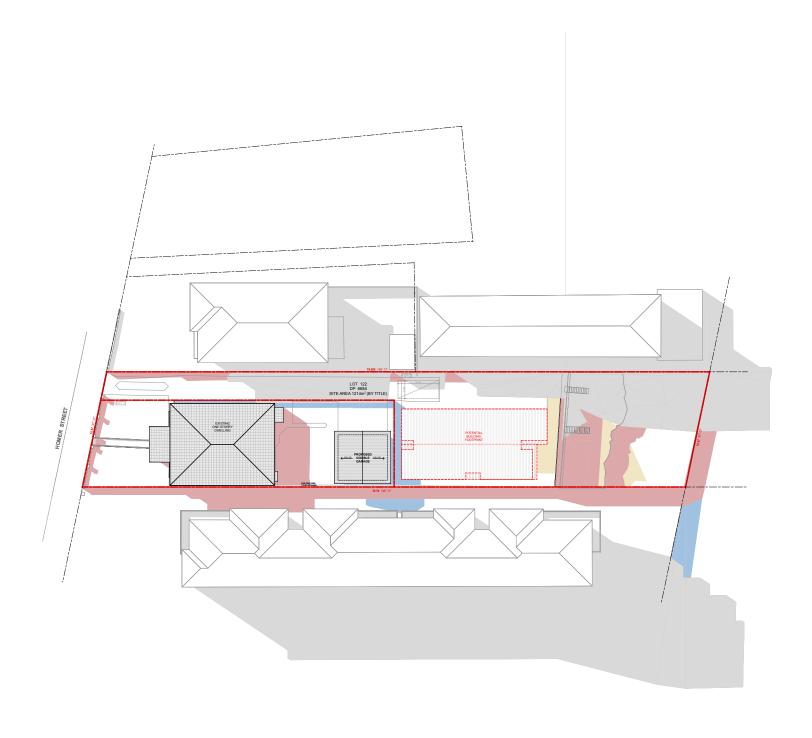
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TITLE:	Shadows Diagrams June 21st	ISSUE	DESCRIPTION	DATE
CLIENT:	Mr. George & Theo Athana	Α	Development Application	13/12/2024
PROJECT:	150 Homer Street, Earlwood	В	Council RFI	19/12/2024
DATE:	19th December 2024	С		
SCALE:	1:500 @ A3	D		





Shadow Diagram - June 21st - 12:00

SHADOW DIAGRAM LEGEND






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Shadows Diagrams June 21st	ISSUE	DESCRIPTION	DATE
Mr. George & Theo Athana	Α	Development Application	13/12/2024
150 Homer Street, Earlwood	В	Council RFI	19/12/2024
19th December 2024	С		
1:500 @ A3	D		
	Mr. George & Theo Athana 150 Homer Street, Earlwood 19th December 2024	Mr. George & Theo Athana 150 Homer Street, Earlwood B 19th December 2024 C	Mr. George & Theo Athana A Development Application 150 Homer Street, Earlwood B Council RFI 19th December 2024 C



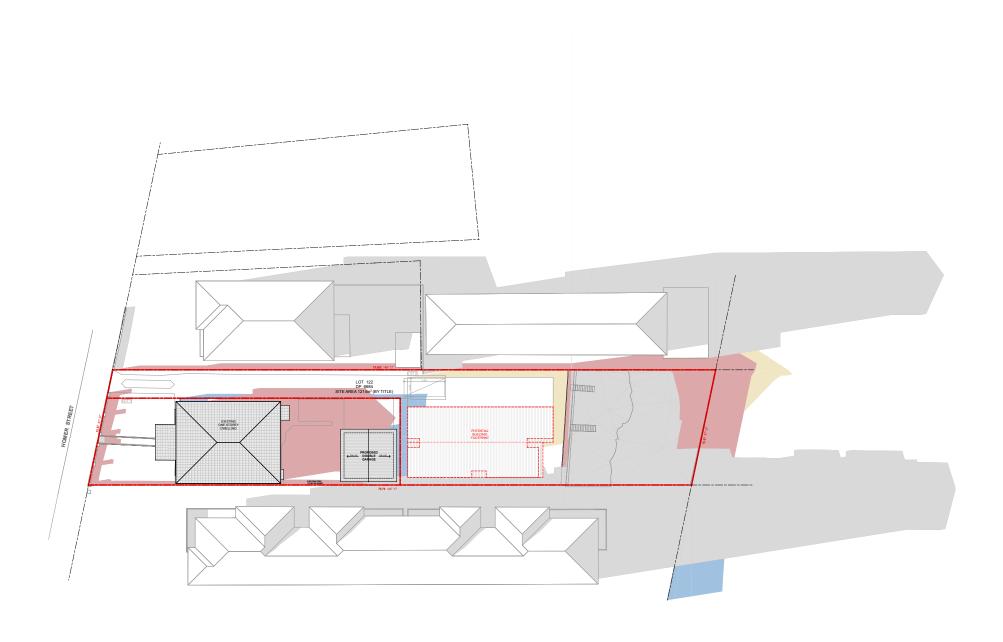

Shadow Diagram - June 21st - 15:00

SHADOW DIAGRAM LEGEND





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E	DATE:	19th December 2024	С		
AL.	SCALE:	1:500 @ A3	D		

